

SAMPLE INFILL

CERTIFIED LOT GRADING PLAN

OF ALL OF _____
PART _____ PLAN _____

IN THE
CITY OF SARNIA

SCALE : 1 : 500

PROPOSED ELEVATION (m) ELEV.

EXISTING ELEVATION (10m GRID) X_____

FINAL ELEVATIONS TO BE $\pm 0.050m$
OF PROPOSED

NOTES

MIN. GRADE AT FOUNDATION (FRONT) _____m

MIN. GRADE AT FOUNDATION (REAR) _____m

DRIVEWAY ELEV. AT GARAGE ENTRANCE _____m

DRIVEWAY HAS A _____% AVE. SLOPE TO ROAD

REAR LOT CATCH BASIN GRADE ELEV. _____m


REAR LOT CATCH BASIN INVERT ELEV. _____m

SHOW SIDE YARD SWALE ELEVATIONS

ENGINEER'S CERTIFICATE :

I HEREBY CERTIFY THAT THE GRADING AND APPURTENANT DRAINAGE WORKS COMPLY WITH PART 3.1.17.1 AND/OR 9.14.6.1 OF THE ONTARIO BUILDING CODE WITH RESPECT TO GRADING.

LENGTH OF _____ REAR LOT

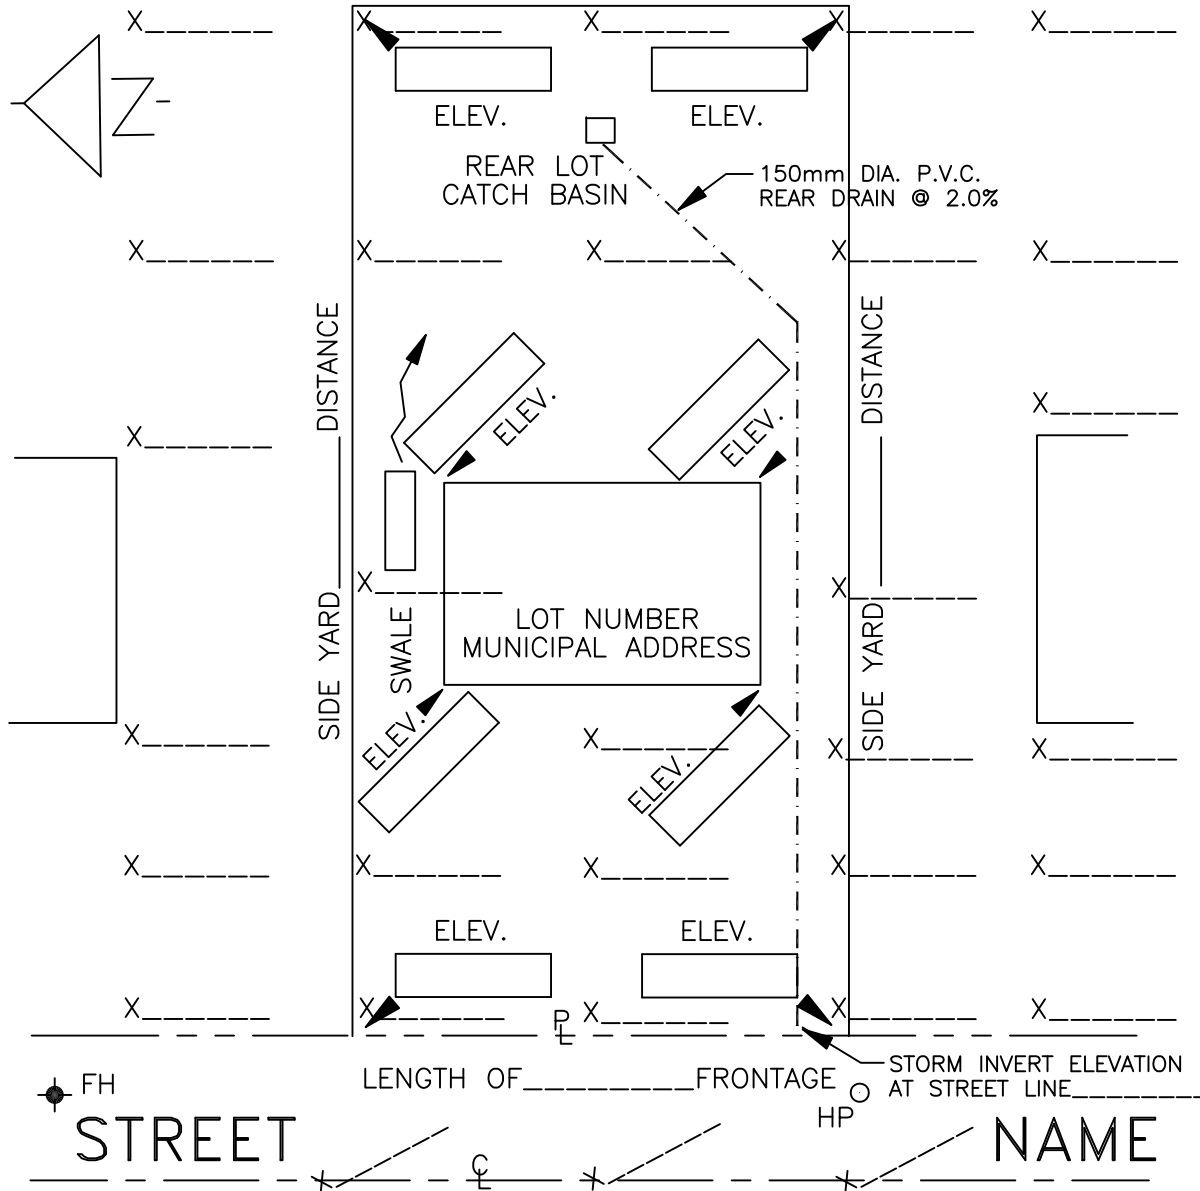

COMPANY _____

GEODETIC BENCH
MARK ELEVATION _____

DESCRIPTION _____

DRAWN BY: _____

CHK' BY: _____

DATE: _____

ENGINEER'S SEAL AND SIGNATURE